

TOWN OF LONGMEADOW, MASSACHUSETTS

Plan of BRANCH STREET RESURFACING PROJECT


SELECT BOARD
MARIE ANGELIDES
THOMAS LACHIUSA
MARK P. GOLD
RICHARD FOSTER
WILLIAM LOW

TOWN MANAGER
STEPHEN J. CRANE

DEPARTMENT OF PUBLIC WORKS
MARIO MAZZA, DIRECTOR
ANDREW KRAR, P.E., TOWN ENGINEER


INDEX

SHEET NUMBER	DESCRIPTION
1	COVER SHEET
2	GENERAL NOTES
3	CONSTRUCTION PLAN
4	DETAILS

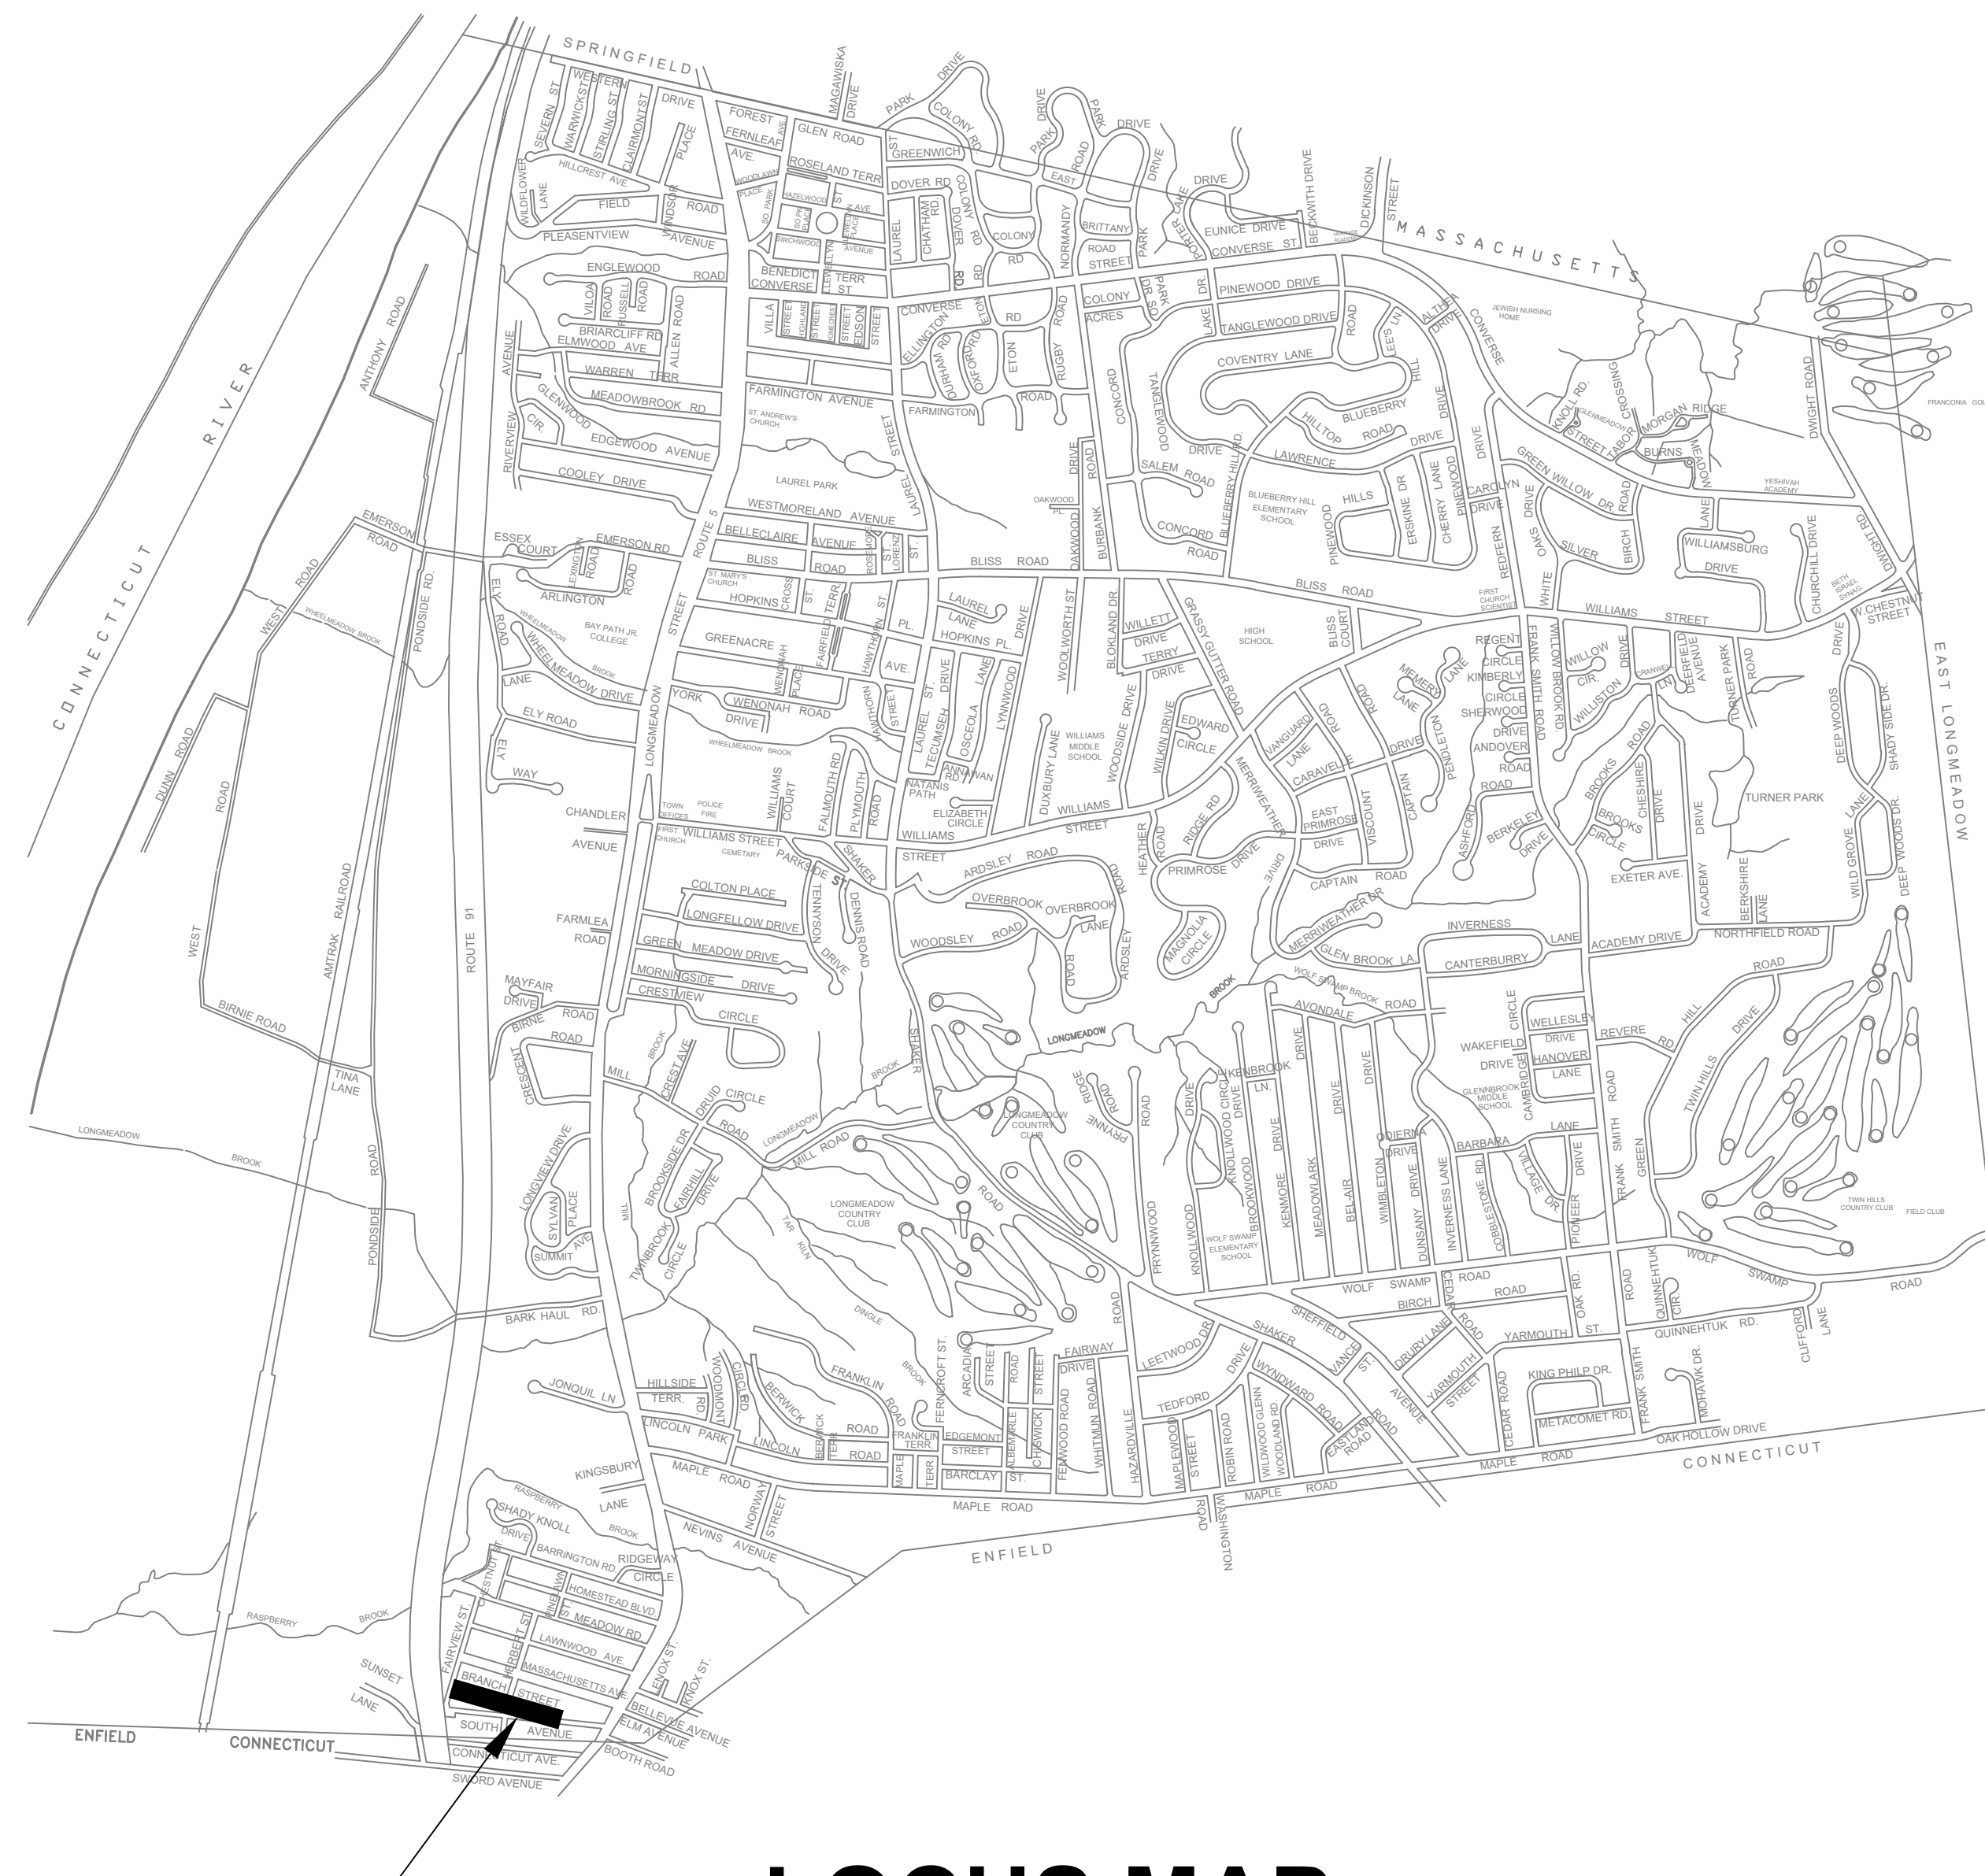

BRANCH STREET
LOCUS MAP
 Not To Scale

**Longmeadow
 Engineering
 Department**

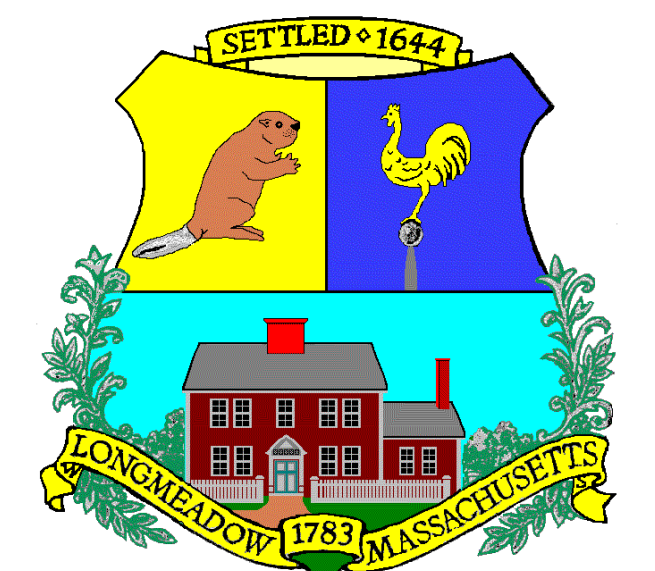

COMPLETE SET 4 SHEETS


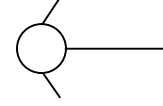














GENERAL NOTES

- EXISTING UTILITY LOCATIONS ARE BASED ON AVAILABLE INFORMATION. THE CONTRACTOR SHALL DETERMINE THE EXACT LOCATION OF UTILITIES BY TEST PIT OR OTHER METHOD WHERE REQUIRED.
- PROPERTY LINE INFORMATION SHOWN ON THE PLANS WAS TAKEN FROM AVAILABLE PARCEL MAPPING AND IS SHOWN FOR REFERENCE PURPOSES ONLY.
- THE CONTRACTOR SHALL MAINTAIN EMERGENCY ACCESS TO ALL PROPERTIES WITHIN THE PROJECT AREA AT ALL TIMES.
- DAMAGE TO THIRD PARTY UNDERGROUND UTILITIES (I.E. WATER, SEWER, OR DRAIN) IS THE RESPONSIBILITY OF THE CONTRACTOR. PROPER REPAIRS SHALL BE MADE BY THE CONTRACTOR OR UTILITY COMPANY, AS ARRANGED BY THE CONTRACTOR, AND AS ACCEPTABLE TO THE ENGINEER. NO COMPENSATION SHALL BE ALLOWED UNDER THIS CONTRACT FOR THE REPAIR OF THIRD-PARTY UTILITIES IN THE PROJECT AREA.
- THE CONTRACTOR SHALL REMOVE AND REPLACE FENCES, MAILBOXES, CURBING, ETC. AS NECESSARY. CONDITION OF REPLACED ITEMS SHALL BE EQUAL OR BETTER THAN ORIGINAL CONDITION PRIOR TO REMOVAL.
- EXISTING WATER MAIN, GAS, AND OTHER UTILITIES ARE SHOWN IN APPROXIMATE LOCATIONS ONLY, AND SHOULD BE VERIFIED BY THE CONTRACTOR.
- PROPERTIES MAY HAVE ROOF/YARD DRAINS CONNECTED TO DRAIN LINE IN THE STREET. THE CONTRACTOR SHALL CONFIRM THEIR LOCATIONS PRIOR TO CONSTRUCTION.
- CONTRACTOR REQUIRED TO CONFIRM LOCATIONS OF IRRIGATION SYSTEMS WITH ALL HOMEOWNERS PRIOR TO COMMENCING CONSTRUCTION ACTIVITIES. IF SPRINKLER SYSTEMS ARE DAMAGED DURING CONSTRUCTION, CONTRACTOR IS REQUIRED TO REPAIR AT NO COST TO THE OWNER.

ABBREVIATIONS

ASBESTOS CEMENT	AC	REINFORCED CONCRETE PIPE	RCP
BITUMINOUS CONCRETE	BIT CONC	RIGHT OF WAY	R.O.W.
BOTTOM OF EXPLORATION	BOE	ROCK PILE	RP
CAST IRON	CI	SANITARY MANHOLE	SMH
CATCH BASIN	CB	STANDARD DIMENSION RATIO	SDR
CHAIN LINK FENCE	C/L FEN	STATION	STA
CHIMNEY	CHIM	STONE BOUND	SB
CEMENT LINED STEEL	CL	STREET LINE	SL
CLEANOUT	CO	SHUT OFF CURB STOP	SO
CONCRETE	CONC	TEMPORARY BENCH MARK	TBM
CONCRETE WALK	C	TELEPHONE POLE	TP
COPPER	CU	TRAFFIC CONTROL	TC
CORRUGATED METAL PIPE	CMP	UNDER CONSTRUCTION	UC
CUT SPIKE	CS	UTILITY POLE	U.P.
DEBRIS	DB	UTILITY STRUCTURE	UT
DIRT PILE	DP	UNDELINEATED WETLAND AREA	UWA
DRAIN MANHOLE	DMH	VITRIFIED CLAY PIPE	VC
DUCTILE IRON	DI	WATER GATE	WG
EASEMENT LINE ELEVATION	EL	WATER SERVICE	WS
EDGE OF PAVEMENT	EOP	WATER TIGHT COVER	WTC
EROSION CONTROL	EC		
GAS GATE	GG		
GATE VALVE	GV		
GEOGRAPHICAL INFORMATION SYSTEMS	GIS		
GRANITE CURB	GR CURB		
GUY WIRE	GY		
GUY POLE	GP		
HOUSE	HSE		
HYDRANT	HYD		
INVERT	INV		
IRON PIPE	IP		
MAIL BOX	MB		
MANHOLE	MH		
MECHANICAL JOINT	MJ		
NOT IN THIS CONTRACT	NITC		
NOT TO SCALE	NTS		
PAVED WALK	PW		
POLYETHYLENE PIPE	PE		
POLY-VINYL CHLORIDE	PVC		
PROPERTY LINE	PL		
PUMP STATION	P.S.		

LEGEND

PROPOSED HYDRANT VALVE ASSEMBLY	
EXISTING HYDRANT VALVE ASSEMBLY	
EXISTING SANITARY MANHOLE	
PROPOSED WATER VALVE	
EXISTING WATER VALVE	
CATCH BASIN	
UTILITY POLE	
TREE	
SHRUB	
MAIL BOX	
PROPOSED WATER LINE	
EXISTING SEWER LINE	
EXISTING WATER LINE	
EXISTING DRAIN LINE	
PROPOSED DRAIN LINE	
EXISTING GAS LINE	

ENGINEERING DEPARTMENT
LONGMEADOW, MASSACHUSETTS


GENERAL NOTES BRANCH STREET RESURFACING PROJECT

SCALE: N.T.S.

DATE: MARCH 2018

SHEET 2 of 4

DRAWN BY: C.M. CHECKED BY: A.K.

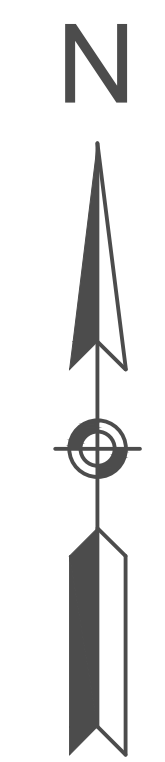

NOTE:
ROADWAY CONTAINS UNDERGROUND ELECTRIC & TELECOMMUNICATIONS.

NOTE:
EXISTING CONDITIONS SHOWN HEREON WERE TAKEN FROM AVAILABLE MAPS, AERIAL PHOTOGRAPHY, FIELD MEASUREMENTS, AND OTHER SOURCES THAT ARE NOT BE ACCURATE, AND WAS PREPARED FOR ILLUSTRATIVE PURPOSES ONLY. PRIOR TO CONSTRUCTION, CONTRACTOR SHALL VERIFY LOCATIONS OF ALL APPLICABLE EXISTING CONDITIONS AND REPORT ANY DISCREPANCIES WITH THE ENGINEER.

ENGINEERING DEPARTMENT LONGMEADOW, MASSACHUSETTS	
CONSTRUCTION PLAN BRANCH STREET RESURFACING PROJECT	
SCALE: 1"=40'	DATE: MARCH 2018
SHEET 3 of 4	DRAWN BY: C.M. CHECKED BY: A.K.

